# SW100

## MIXED USE DEVELOPMENT 35-41 FLINDERS STREET, WOLLONGONG STORMWATER CONCEPT DESIGN



	DRAWINGS LIST						
REV	TITLE	DWG No.	SHEET No.				
A	COVER SHEET	SW100	1				
A	STORMWATER CONCEPT DESIGN - BASEMENT 2 PLAN	SW200	2				
A	STORMWATER CONCEPT DESIGN - RETAIL LEVEL PLAN	SW201	3				
A	STORMWATER CONCEPT DESIGN - GROUND FLOOR PLAN	SW202	4				
A	STORMWATER CONCEPT DESIGN - ROOF PLAN	SW203	5				
A	STORMWATER CONCEPT DESIGN - DETAILS SHEET	SW300	6				
A	EROSION AND SEDIMENT CONTROL - PLAN AND DETAILS	SW400	7				
A	STORMWATER CONCEPT DESIGN - MUSIC CATCHMENT PLAN	SW500	8				

LOCALITY PLAN NOT TO SCALE COPYRIGHT OF SIX MAPS



#### PREPARED BY:

SGC Consulting Engineers Suite 5.03, Level 5 156 Pacific Highway St. Leonards, NSW 2065 T: +61 2 8883 4239 Email: office@sgce.com.au Web: www.sgce.com.au

#### ARCHITECT:



### CLIENT:

LEVEL 33 DEVELOPMENTS



4-tender

5-construction

6-other

SURVEY

000 SERVICES ON THIS DRAWING ARE SHOWN BELOW SLAB U.N.O 

PUMP-OUT PIT NOTE:

INSTALL WITH THE FOLLOWING ITEMS: - 900SQ HEAVY DUTY STEEL GRATED LID FOR ACCESS AND MAINTENANCE PURPOSES. -CONFINED SPACE SIGN ABOVE PUMP OUT PIT FOR PUBLIC AWARENESS AND WARNING. -STEP IRONS. REFER TO DETAILS. -PUMPOUT PIT CONTROL BOX (CTRL) TO MANUFACTURERS SPECIFICATIONS. LOCATIONS TO BE CONFIRMED WITH ARCHITECT. -PUMPS TO OPERATE IN ALTERNATE MODE TO INCREASE LIFESPAN -INSTALL VISIBLE FLASHING LIGHT SYSTEM IN CASE OF PUMP FAILURE -INSTALL 1x MAN 550/2/80 A1FT/50 FROM ZENIT WATER SOLUTIONS OR SIMILAR 3 PHASE

SUBSOIL DESIGN CALCS: THE AREA OF DRIVEWAY RAMP IS COVERED THEREFORE IN ACCORDANCE WITH AS3500, THE

MINIMUM PUMPOUT PIT SIZE IS 3m<sup>3</sup>.

PUMPS WITH 10L/s OUTFLOW FOR 13m HEAD

GEO-TECHNICAL NOTE:

BASEMENT DRAINAGE DESIGN SUBJECT TO GEOTECHNICAL INVESTIGATION (INCLUDING WATER TABLE AND SEEPAGE RATE) AND STRUCTURAL DESIGN OF WALLS AND SLABS.


GEO-TECHNICAL ENGINEER TO CONFIRM IF THE BASEMENT NEEDS TO BE TANKED.

PUMP NOTE

ALL STORMWATER PUMPS TO BE CLASS 1 ZONE 2 FLAME SAFE TO ELECTRICAL CONSULTANT'S REQUIREMENTS.

SURFACE GRADING

SURFACES ARE TO BE GRADED TOWARDS SURFACE INLET PIT (GSIP) AND RAINWATER OUTLET (RWO) AT 1% MIN. FOR UNCOVERED

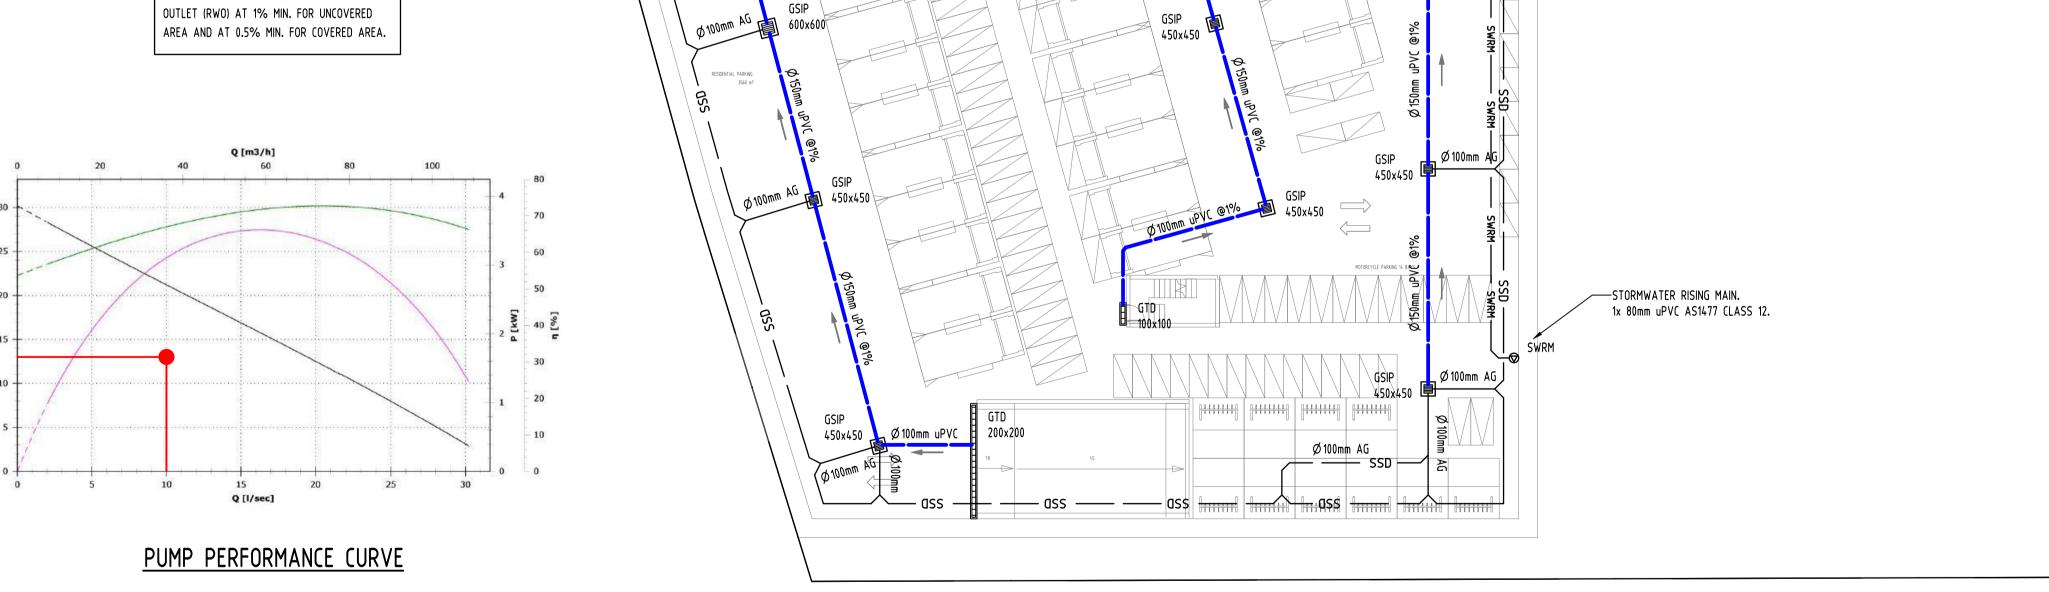

Ø150mm uPVC @1%

Ø150mm uPVC @1%

LIFT TO BE TANKED TO-

600×600

STRUCTURAL ENGINEER DETAILS.

450x450

GSIP

600x600

450x450

100×100

Ø150mm uPVC <u>@1%</u>⊳

Ø 150mm uPVC @1%

BASEMENT 2

GSIP

600x600

GSIP

600x600

RL:2.925

600x600

Reference Coordination Drawing QUALITY CONTROL Discipline SC 25.06.21 2 STRUCT
SC 21.06.21 1 MECH
SC 18.06.21 1 ELEC DIMENSIONS NOT SHOWN TO BE CHECKED ON CHECKED

SITE. DO NOT SCALE OF THIS DRAWING. A ISSUE FOR DEVELOPMENT APPLICATION P3 PRELIMINARY ISSUE POSITIONS OF AUTHORITIES MAINS AND/OR EXISTING SERVICES ARE TO BE CHECKED PRELIMINARY ISSUE DESIGNED DATE 25.06.21 SC 04.06.21 1 HYD P1 PRELIMINARY ISSUE PRIOR TO COMMENCEMENT OF WORK, REPORT ANY DISCREPANCIES TO THE CONSULTING by Date Status FIRE Issue Last revision title ENGINEER FOR DECISION/CLARIFICATION
BEFORE PROCEEDING WITH THE WORK. THIS Issuer internal sequence and revision history DRAWING IS TO BE READ IN CONJUNCTION WITH THE SPECIFICATIONS AND OTHER APPROVED SH 2-development application 3-construction certificate

CONSULTANTS' DRAWINGS.

DATE 25.06.21

WARNING: THE DESIGNS, DRAWINGS, SPECIFICATIONS AND THE COPYRIGHT HEREIN REMAIN THE SOLE INTELLECTUAL PROPERTY OF S&G CONSULTANTS PTY LTD AND MUST NOT BE USED, COPIED, ALTERED OR REPRODUCED WHOLLY OR IN PART IN ANY FORM WITHOUT THE WRITTEN CONSENT OF S&G CONSULTANTS PTY LTD

LEVEL 33 DEVELOPMENTS 0m 2 4 6 8 SCALE 1:200 ON ORIGINAL SIZE

CLIENT

**LEVEL ARCHITECTURAL DIVISION** T +612 8199 1144 www.level33.com.au Nominated Registered Architect George O'Donovan NSW 6763

ARCHITECT

Ø 100mm AG

600x600

\_Ø100mm AG

GSIP

📕 Ø 100mm A|G

\_ Ø 100mm A

900x900

BASEMENT PUMP OUT PIT:

MINIMUM VOLUME REQUIRED:3.0m3 VOLUME PROVIDED:6.0m3

—PUMP OUT PIT CONTROL BOX.

-INSTALL WARNING FLASH LIGHT

TO PROVIDE INDICATION OF

PUMP FAILURE

TO MANUFACTURERS SPECIFICATIONS.

TWL:2.50 IL:0.50 HEIGHT:2.0m

Ø150mm uPVC @1%

☐ Ø 150mm uPVC

GSIP

GSIP

600x600

GSIP 트



Suite 5.03, Level 5, 156 PACIFIC HIGHWAY ST. LEONARDS, NSW 2065 T: +61 2 8883 4239 Email: office@sgce.com.au 35-41 FLINDERS STREET, Web: www.sgce.com.au

A.B.N. 21 118 222 530

PROJECT MIXED USE DEVELOPMENT WOLLONGONG

Scale (at original size)

1:200 @ A1


Datum


A.H.D.


2 OF 8


FOR APPROVAL NOT TO BE USED FOR CONSTRUCTION PURPOSES


STORMWATER CONCEPT DESIGN BASEMENT 2

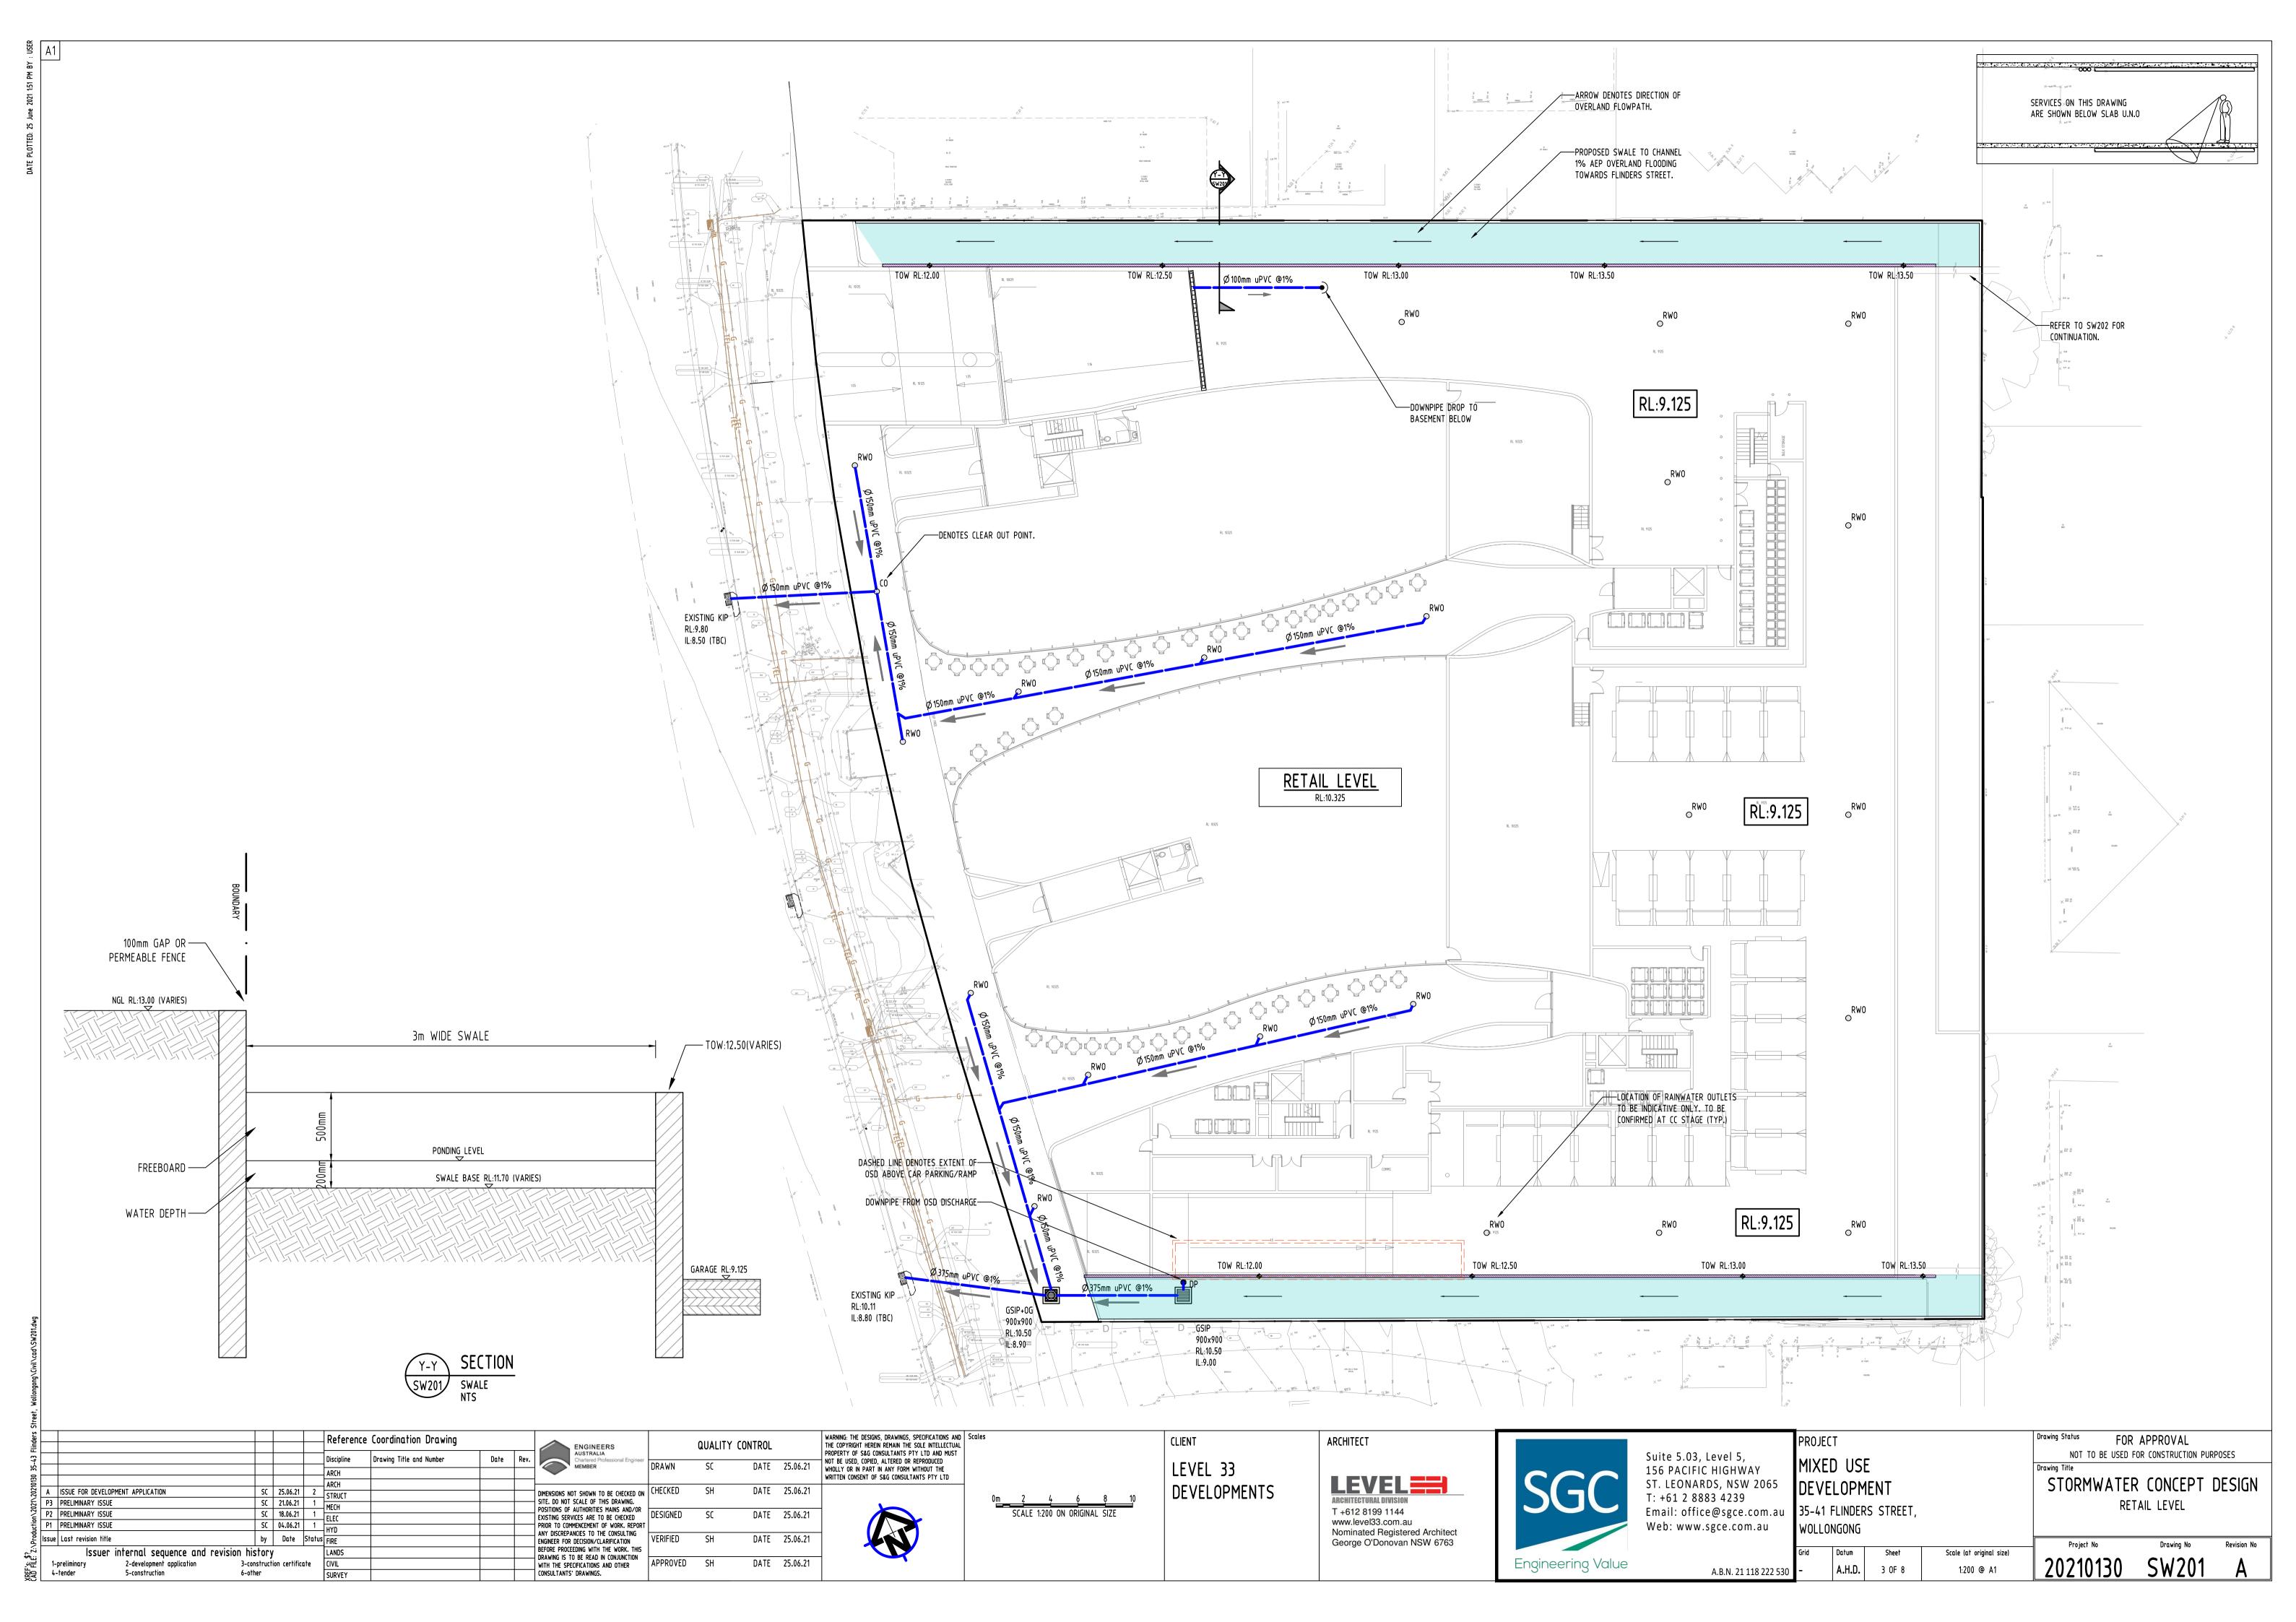

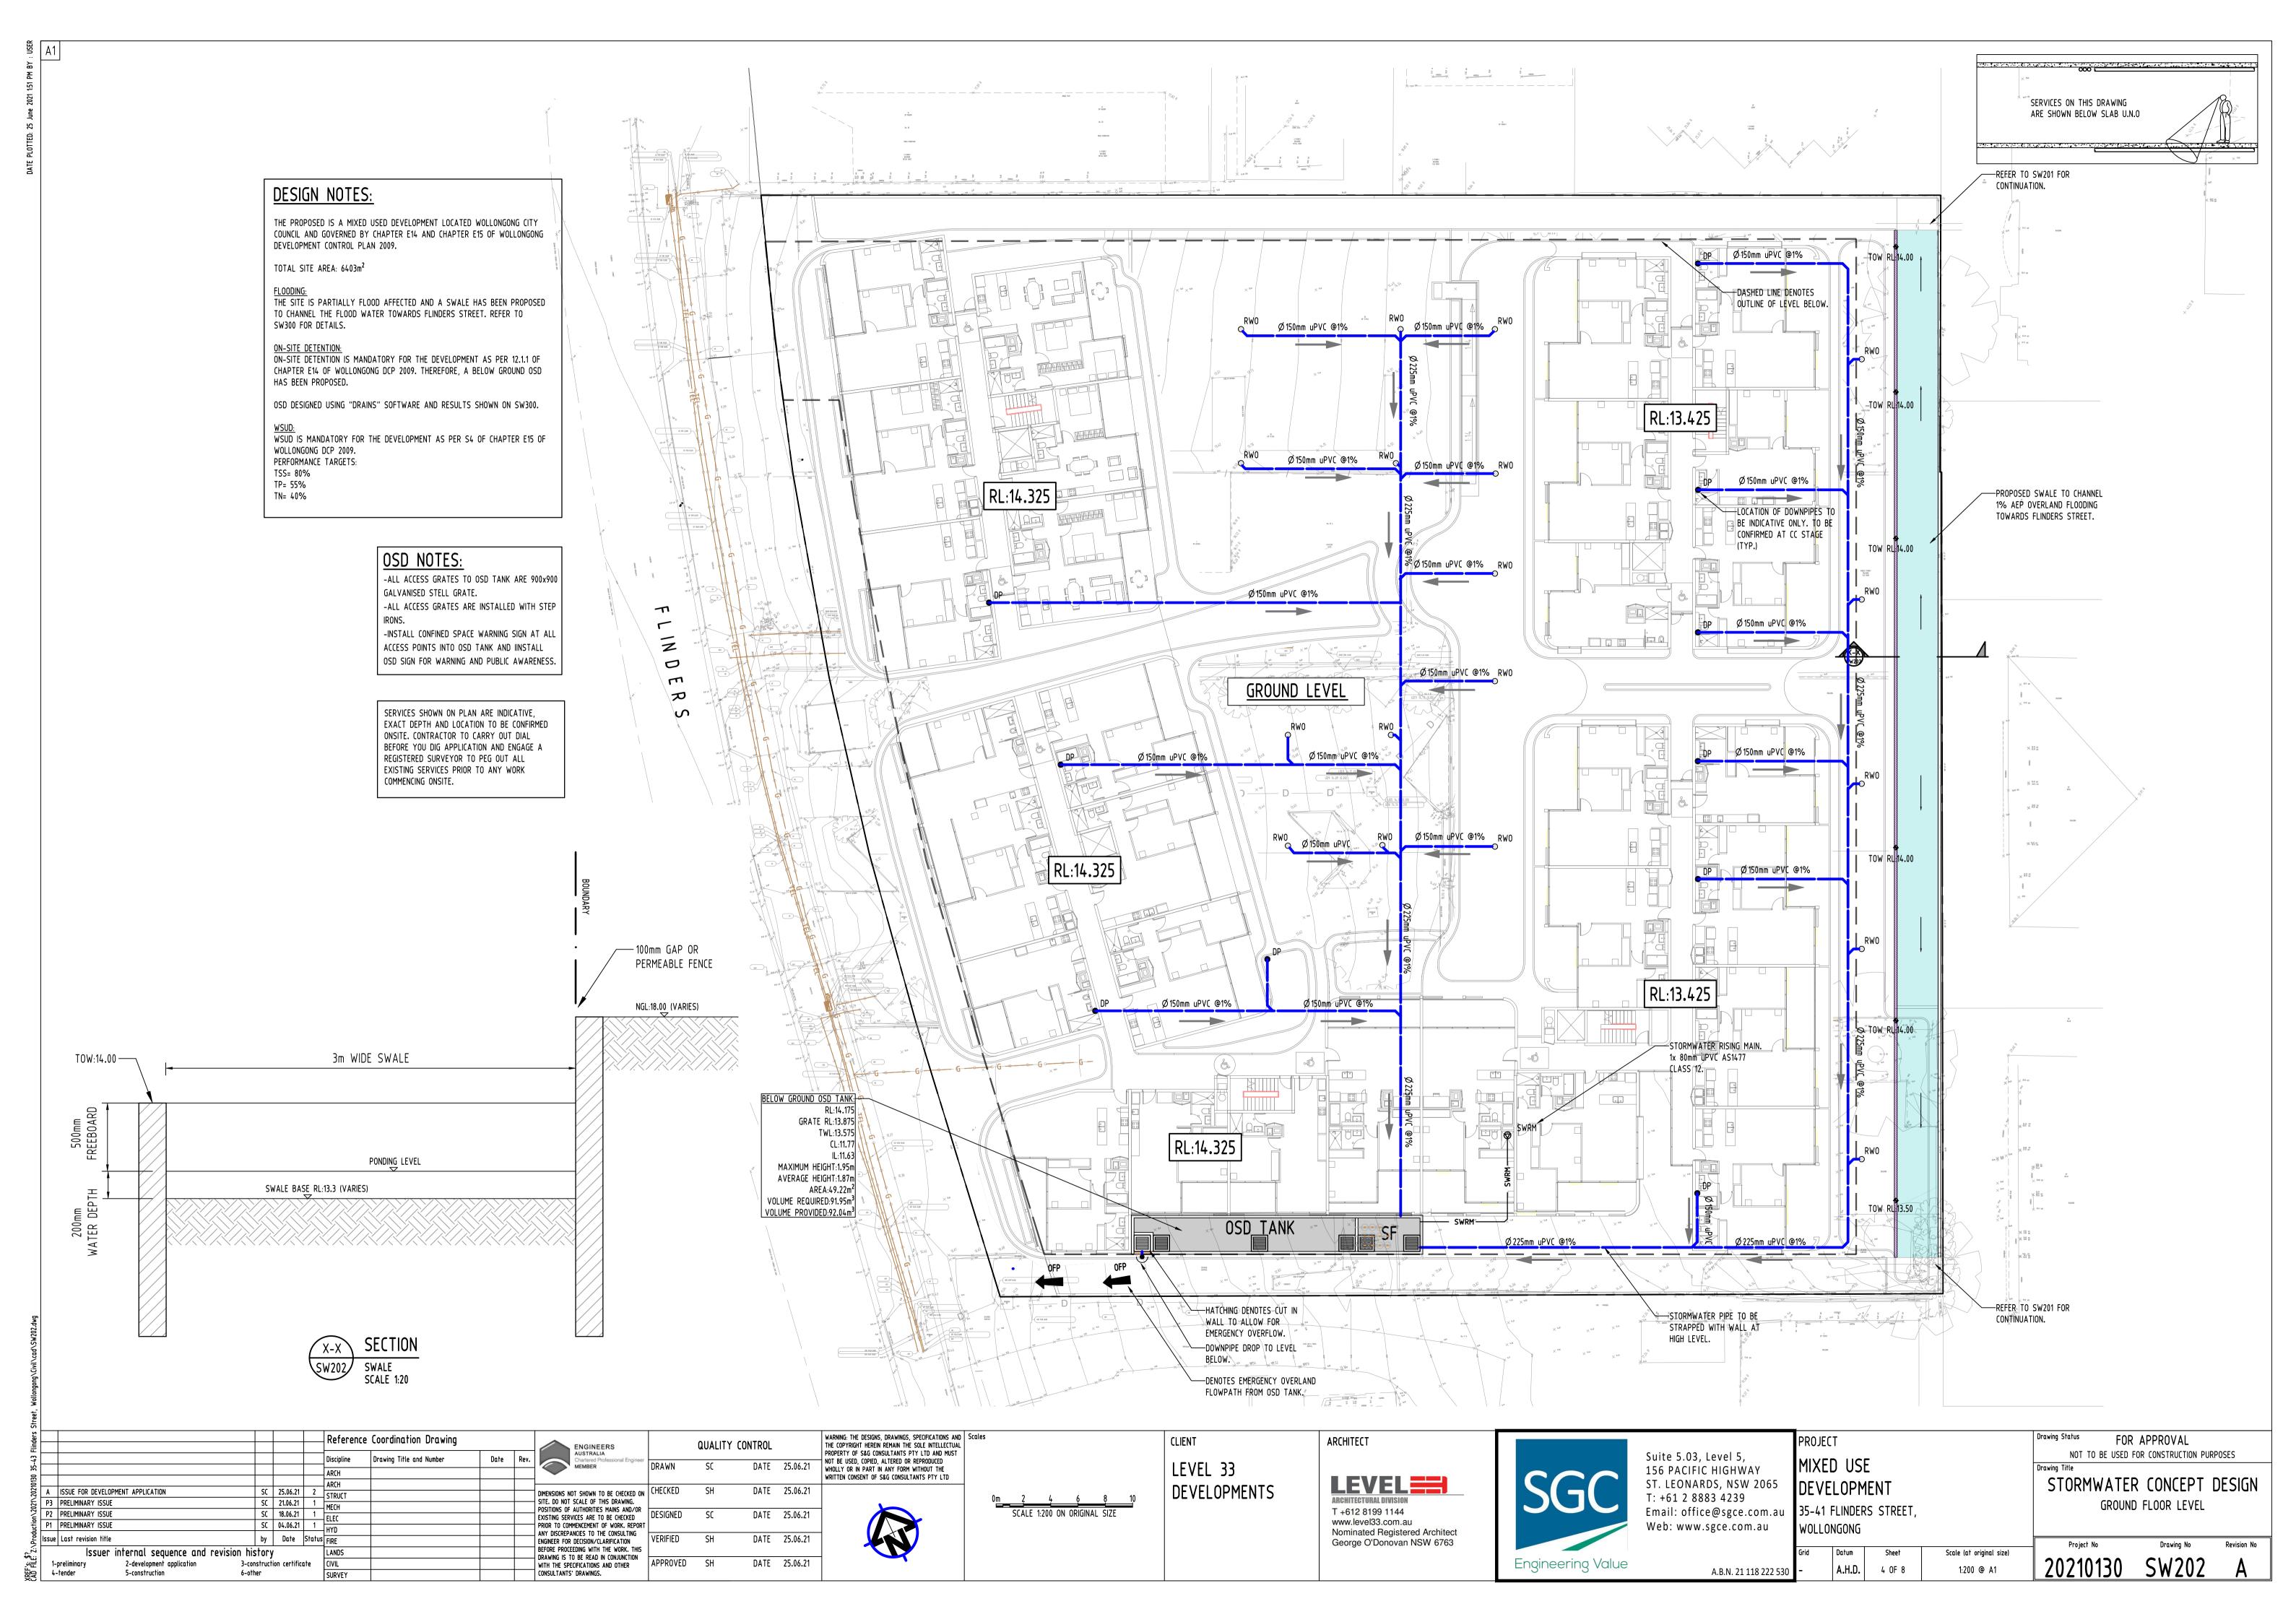


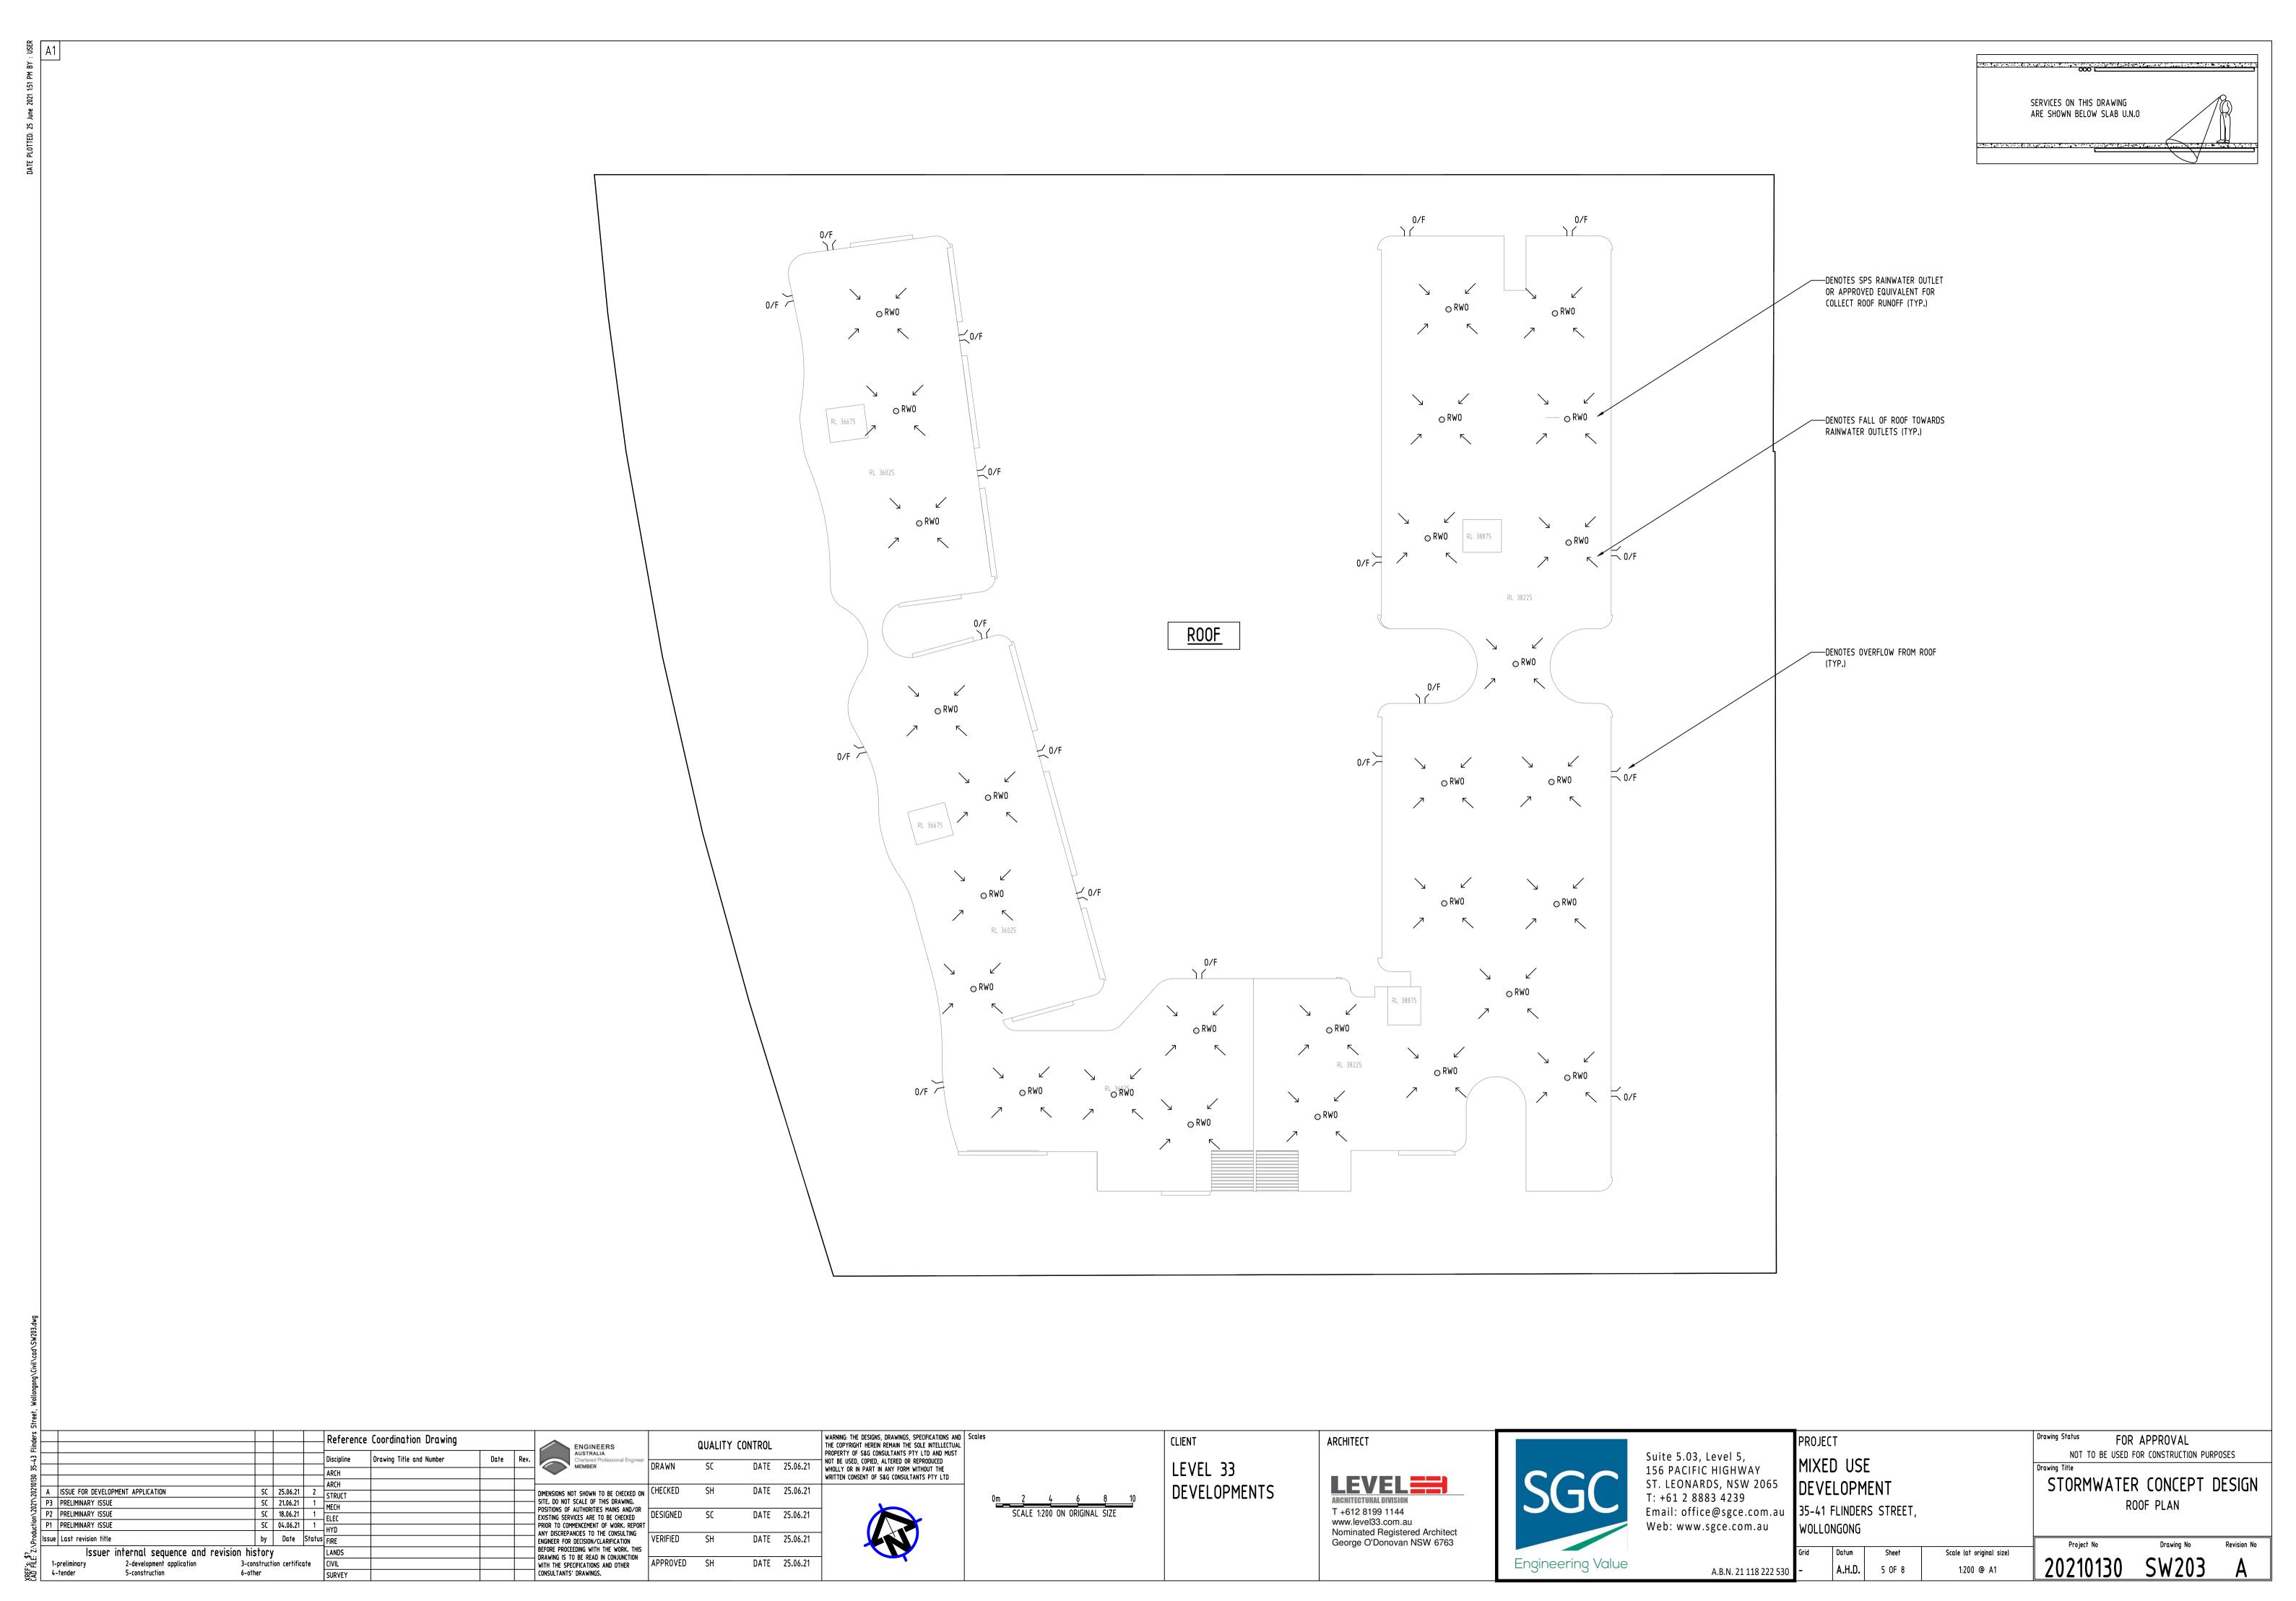

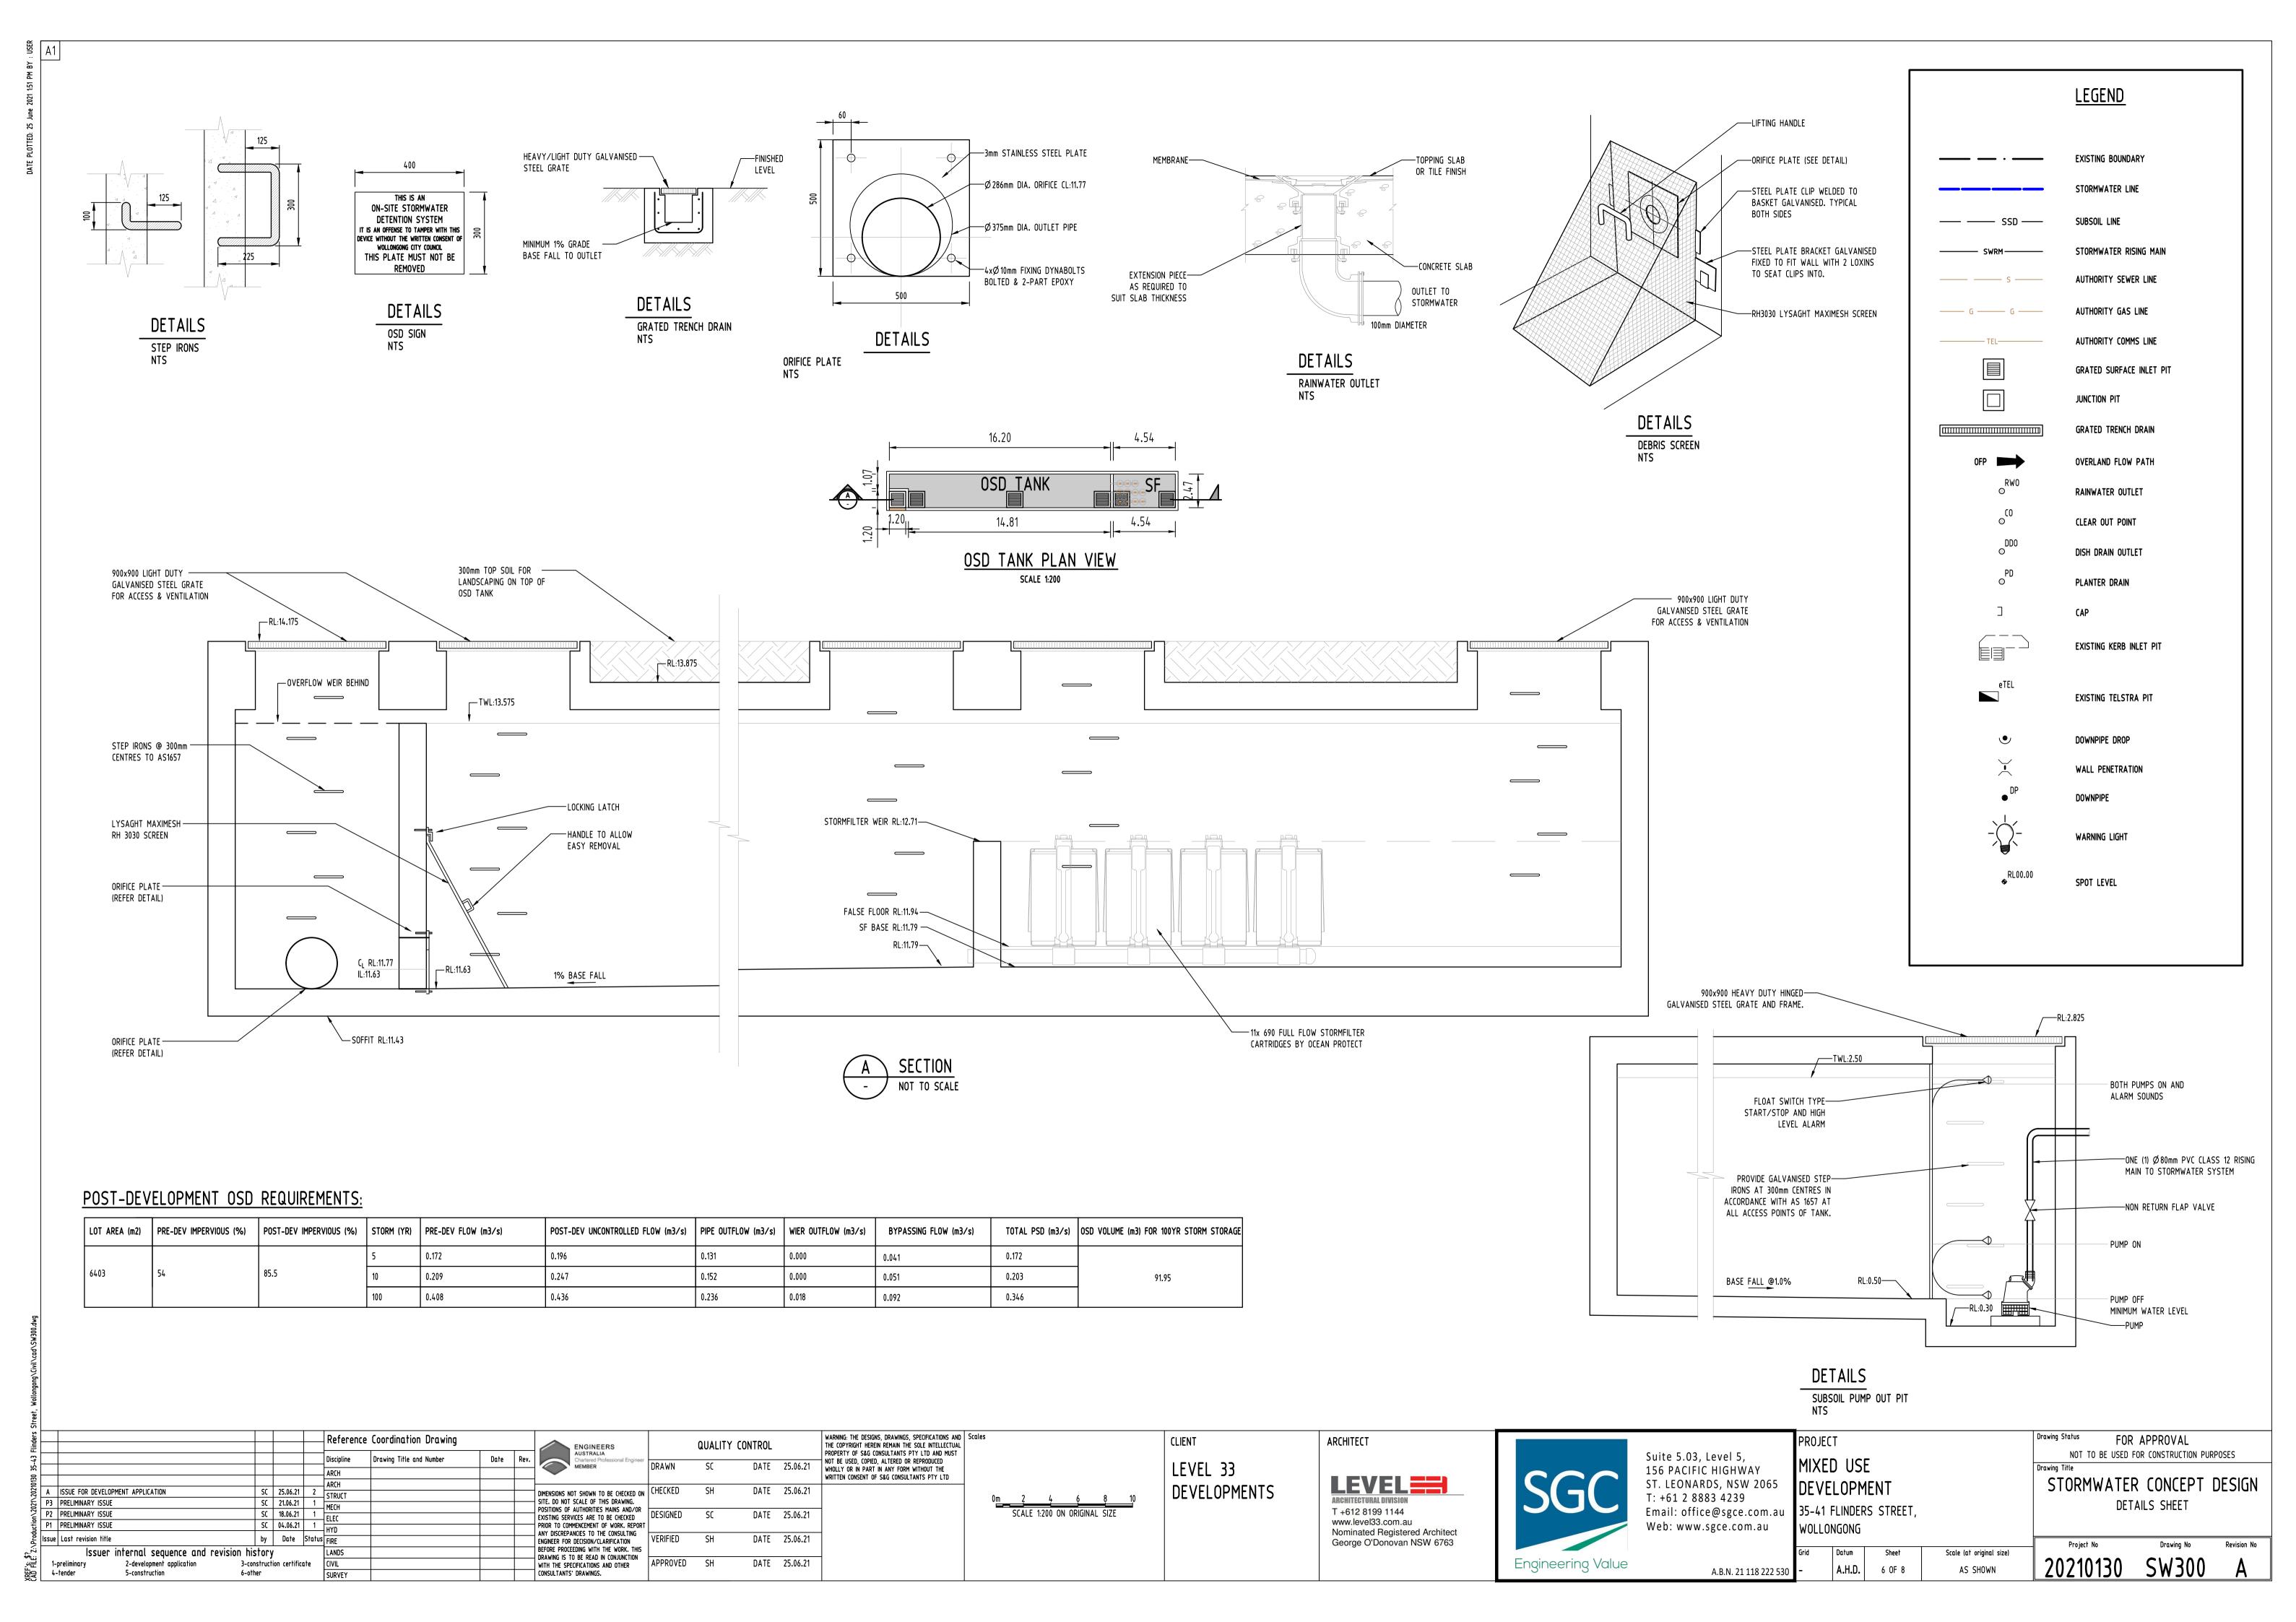

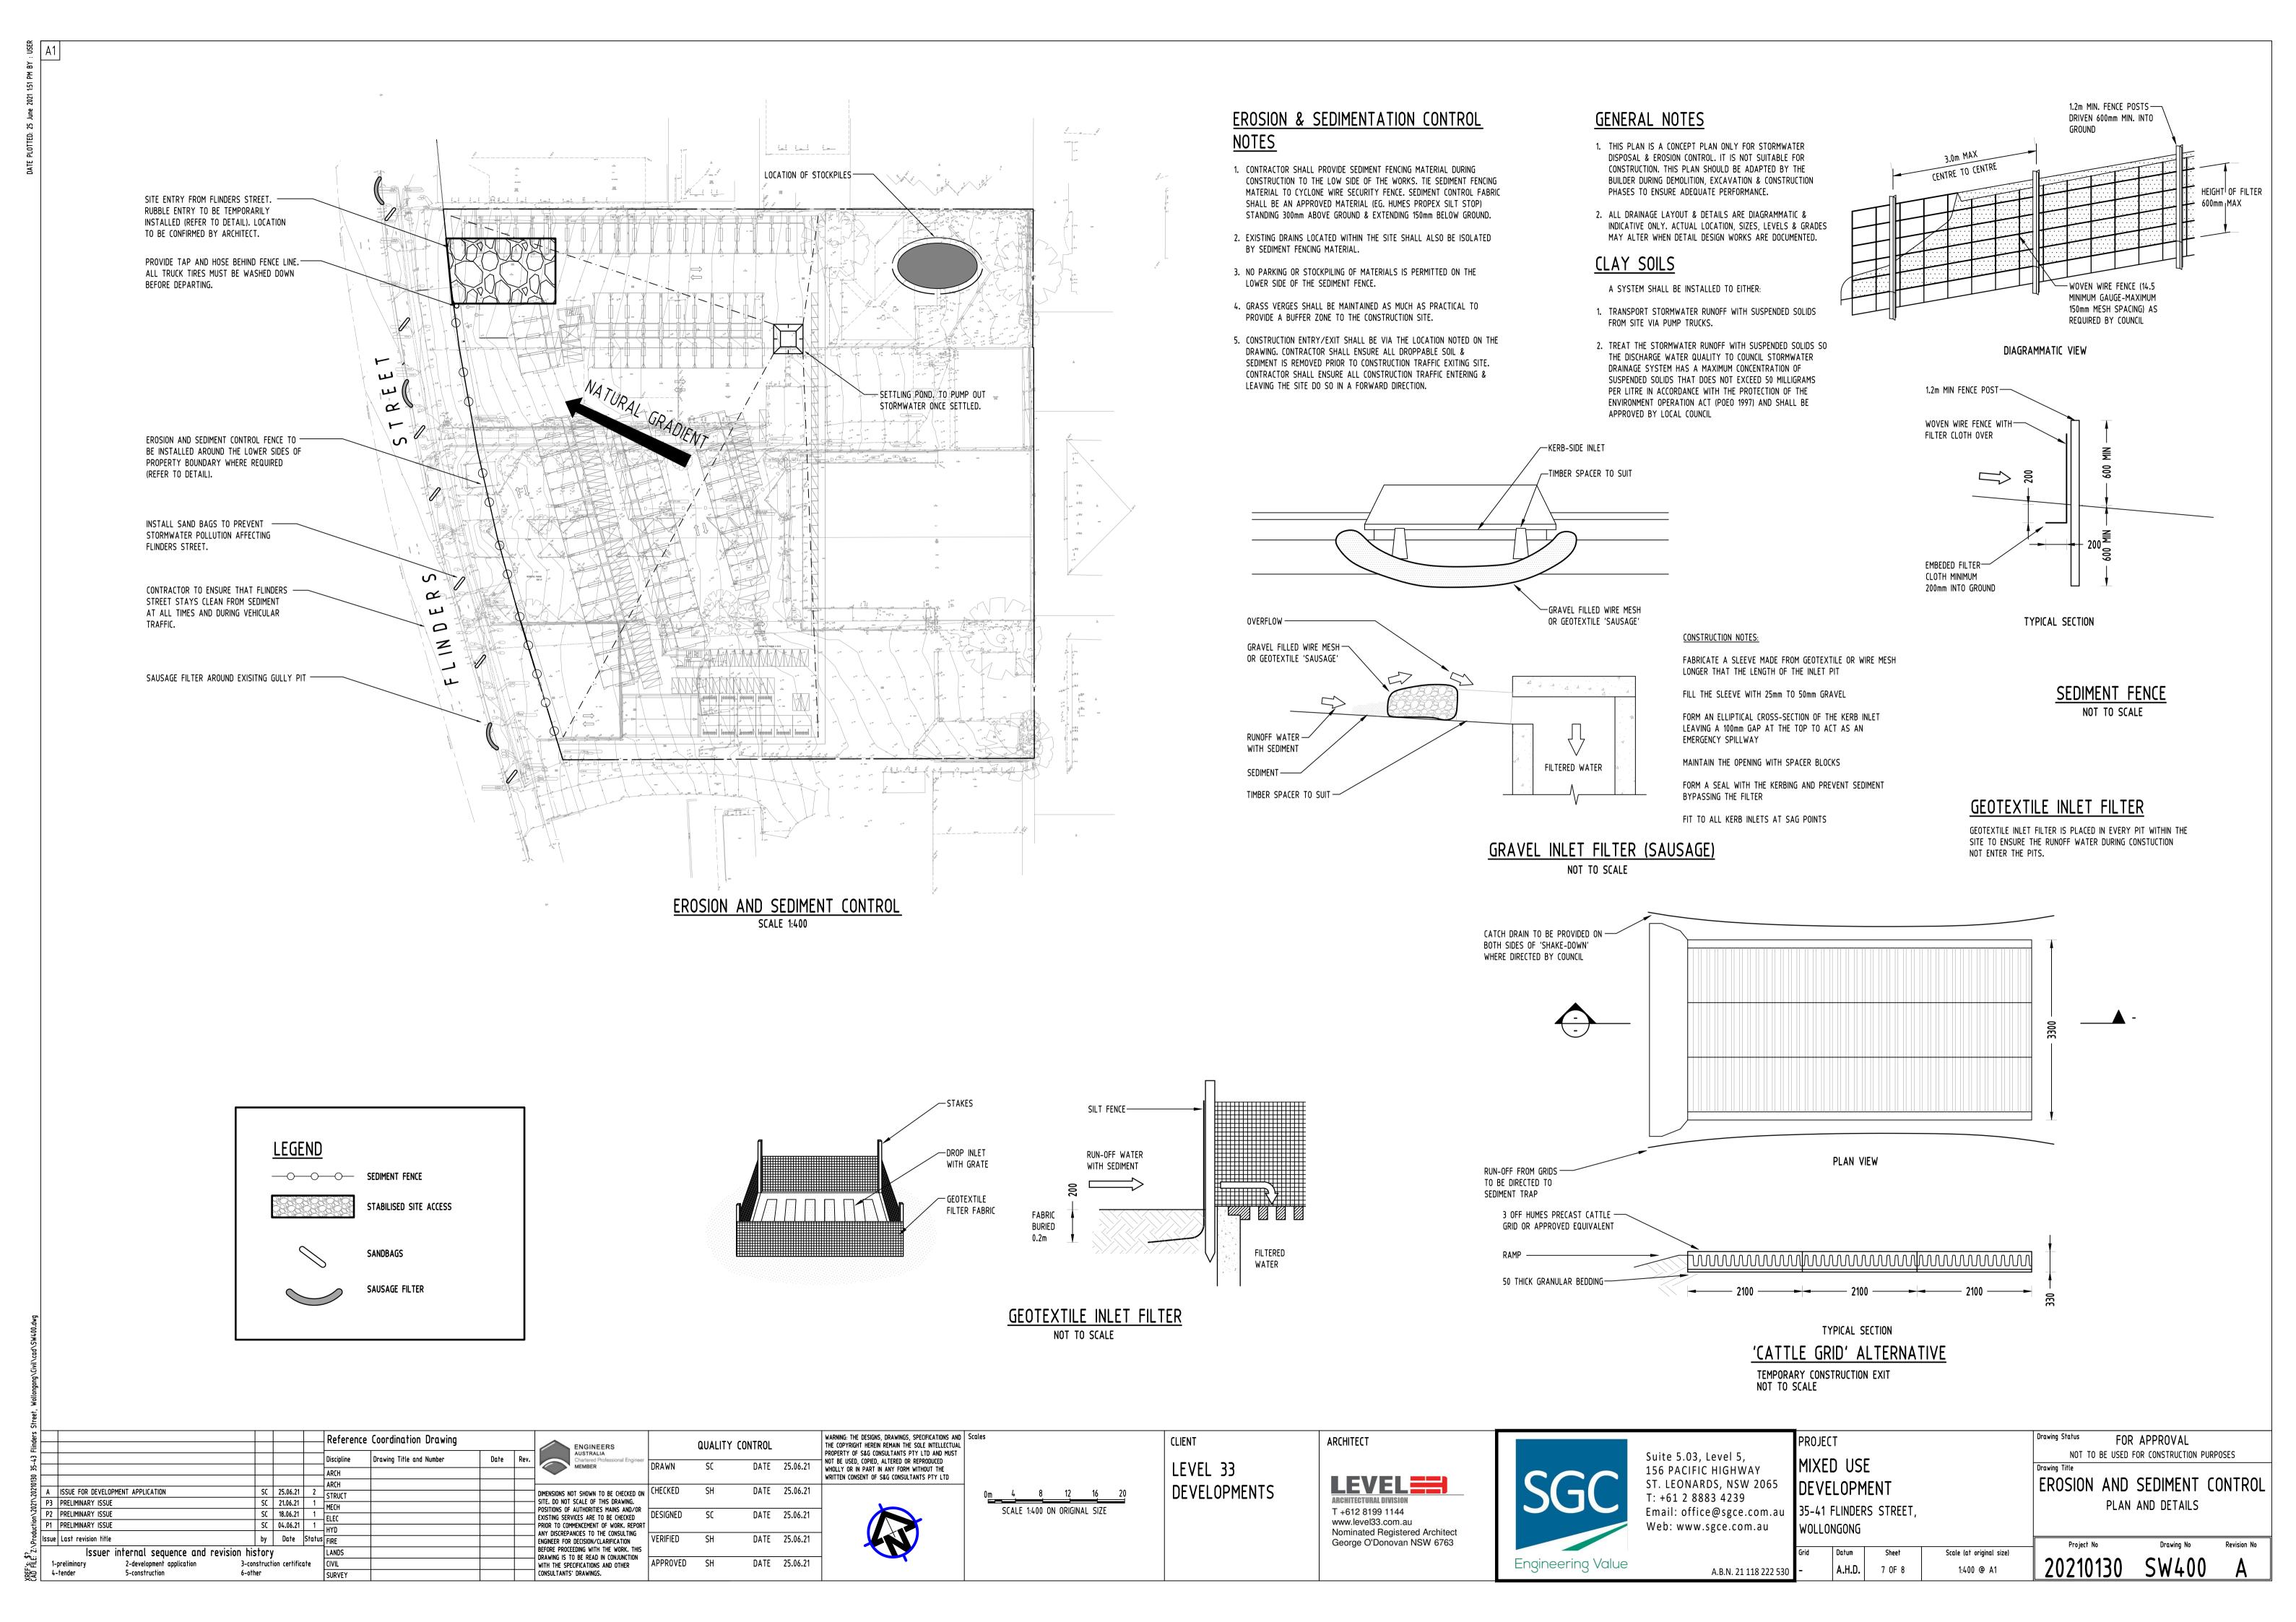




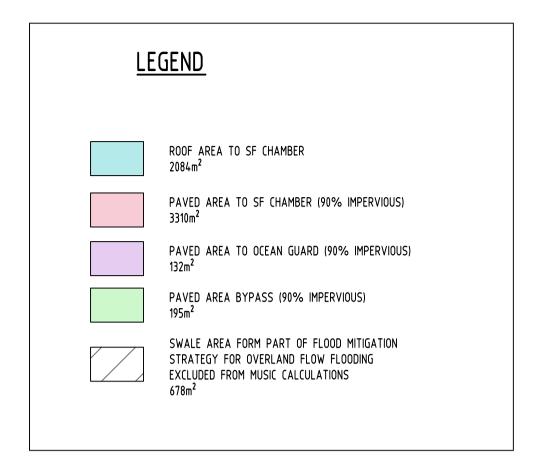



#### MUSIC CATCHMENT SITE BREAK-UP PLAN

SCALE 1:400

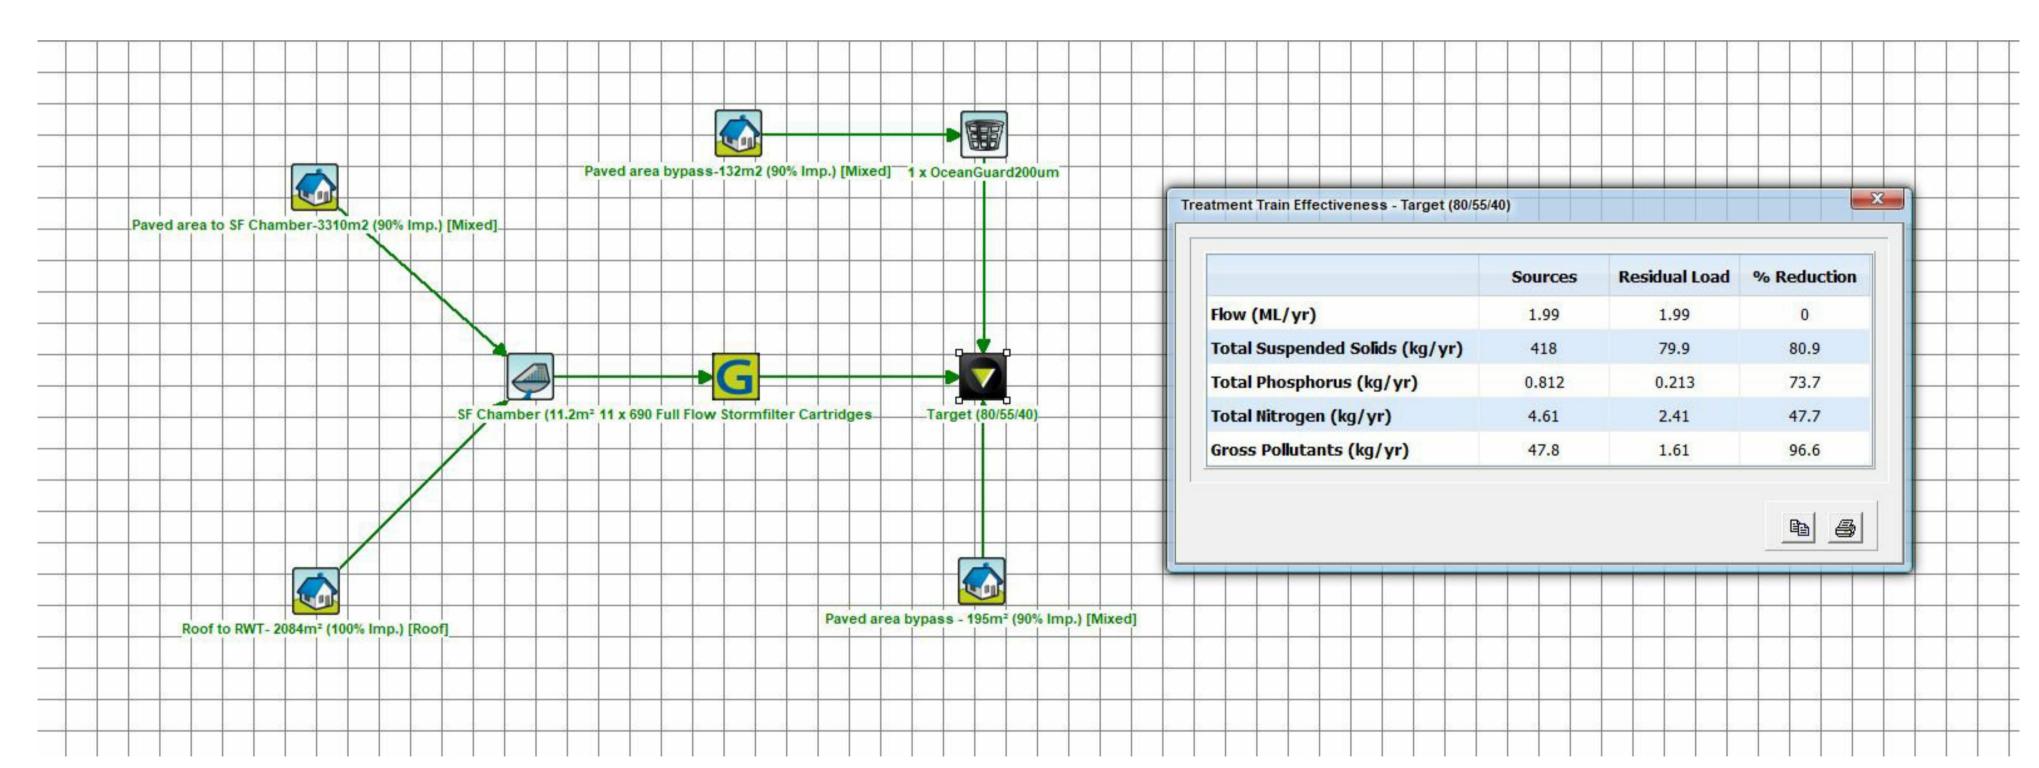

Flinders								Reference	Coordination Drawing			ENGINEERS	Q
-43								Discipline	Drawing Title and Number	Date	Rev.	AUSTRALIA Chartered Professional Engineer	DRAWN
30 35								ARCH				MEMBER	DKAWN
.20210130	Α	ISSUE FOR DEVELOPN	MENT APPLICATION		SC	25.06.21	2	ARCH STRUCT				DIMENSIONS NOT SHOWN TO BE CHECKED ON	CHECKED
2021\	Р3	PRELIMINARY ISSUE			SC	21.06.21	1	MECH				SITE. DO NOT SCALE OF THIS DRAWING. POSITIONS OF AUTHORITIES MAINS AND/OR	
_	P2	PRELIMINARY ISSUE			SC	18.06.21	1	ELEC				EXISTING SERVICES ARE TO BE CHECKED	DESIGNED
duction`	P1	PRELIMINARY ISSUE			SC	04.06.21	1	HYD				PRIOR TO COMMENCEMENT OF WORK. REPORT	
Pro	Issue	Last revision title			by	Date	Status	FIRE				ANY DISCREPANCIES TO THE CONSULTING ENGINEER FOR DECISION/CLARIFICATION	VERIFIED
:     		Issuer i	nternal sequence and rev	ision hist	ory	1		LANDS				BEFORE PROCEEDING WITH THE WORK. THIS DRAWING IS TO BE READ IN CONJUNCTION	
XREF's: \$? :AD file: z:\		-preliminary	2-development application	3-cons	tructi	ion certific	ıte	CIVIL				WITH THE SPECIFICATIONS AND OTHER	APPROVED
APE APE	4-	-tender	5-construction	6-othe	r			SURVEY				CONSULTANTS' DRAWINGS.	

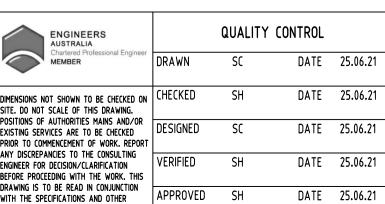

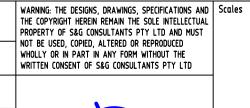

0<u>m 2 4 6 8 10</u> SCALE 1:400 ON ORIGINAL SIZE

LEVEL 33 DEVELOPMENTS

CLIENT



ARCHITECT



Suite 5.03, Level 5,
156 PACIFIC HIGHWAY
ST. LEONARDS, NSW 2065
T: +61 2 8883 4239
Email: office@sgce.com.au
Web: www.sgce.com.au
•

A.B.N. 21 118 222 530

	PROJECT
	MIXED USE
65	DEVELOPMENT
n.au	35-41 FLINDERS STREET
u	WOLLONGONG

Datum

A.H.D.

8 OF 8

Drawing Status		FOF	<b>₹</b> A	PPROVAL	
NOT	TO BE	USED	FOR	CONSTRUCTION	PURPOS
Drawing Title					
STOR	MW/	<b>\TE</b>	R	CONCEP.	T DE

Scale (at original size)

1:200 @ A1

MUSIC CATCHMENT PLAN